
ELECTRICAL SCHEDULE HEIGHT A.F.F. VOLTS TO OPERATE: /REMARKS OUTLET WALL CEILING TYPE 105 | 120 1 | 15.0 A (1800 W) EA. FOR TORTILLA WARMERS (2-LOCATIONS) 106 | 120 1 | 15.0 A (1800 W) FOR QUESADILLA TOASTER (2-LOCATIONS) 12" 107 | 120 10.0 A FOR MOBILE FOOD WARMER 12" 108 | 120 12.5 A NEMA 5-20P FOR 2-WELL HOT FOOD TABLE 110 208 16.64 A NEMA 6-30P FOR HOT FOOD TABLE 125 208 22.0 A L15-30P BTC ON CONVECTION RETHERMOLIZER 132 | 120 1 10.0 A NEMA 5-15P FOR MOBILE WARMING CABINET 135 | 120 NEMA 5-15P FOR CHIP WARMER 1 4.0 A 136 | 120 J-BOX BTC ON FIXTURE MOUNTED SCO FOR CHIP WARMER 8.0 A 1 137 | 120 NEMA 5-15P FOR CHIP WARMER 1 4.0 A 205-60 120 NEMA 15-5P SANDWICH TOP REFRIGERATOR 9.0 A 1 210-36 120 5.5 A FOR WORK—TOP REFRIGERATOR 1 215-27 120 6.8 A FOR WORK—TOP FREEZER 218 | 120 4.0 A SANDWICH TOP REFRIGERATOR (2-LOCATIONS) 220 | 120 78" 10.5 A FOR MERCHANDISER 225 | 120 BTC ON ICE MACHINE 12.8 A 120" 235 | 120 BTC ON COOLER LIGHTS 2.7 A 236 | 208 5.9 A SU 4" BTC ON COOLER COMPRESSOR ON ROOF 405 | 120 20.0 A BTC ON PRE-WIRED HOOD LIGHTS (INDICATOR SWITCH 530 120 15.0 A 61" FOR GENERAL DUTY (3-LOCATIONS) 535 120 15.0 A FOR GENERAL DUTY (2-LOCATIONS) 30" 705 | 208 BTC ON ICE MAKER HEAD 11.0 A 30" 710 | 120 5.2 A FOR DRINK DISPENSER 72" BAG-N-BOX RACK FOR DRINK CARBONATOR (2-LOC) 710.1 | 120 15.0 A 715 | 120 FOR ICE TEA BREWER 14.87 A 785 | 120 0.5A FOR DIGITAL TIMER BTC ON FIXTURE MOUNTED RECEPTACLES FOR (2) POS REGISTERS BY OWNER (DEDICATED CIRCUIT, ISOLATED GROUND) 815 120 20.0 A

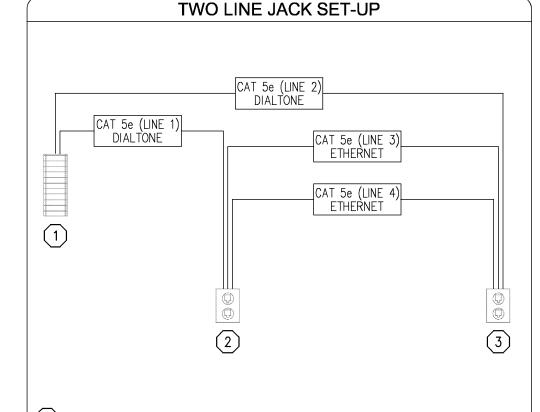

- 1 D-MARC
- OFFICE WALL PLATE (LOCATED IN OFFICE)
 OFFICE WALL PLATE SHOULD BE TERMINATED WITH THE FOLLOWING JACK(S):
 LINE 1

 LINE 3

 LINE 4

 PAIR 1 = VOICE

 PAIR 1 = ETHERNET T568B

 PAIR 2 = FAX

 PAIR 2 = ETHERNET T568B

 PAIR 3 = OPEN

 PAIR 3 = ETHERNET T568B

 PAIR 4 = OPEN

 PAIR 4 = ETHERNET T568B

 PAIR 4 = ETHERNET T568B
- POS CABINET WALL PLATE (LOCATED INSIDE OF POS STATION)
 POS CABINET WALL PLATE SHOULD BE TERMINATED WITH THE FOLLOWING JACK(S):
 LINE 2

 PAIR 1 = VOICE
 PAIR 1 = ETHERNET T568B
 PAIR 2 = OPEN
 PAIR 2 = ETHERNET T568B
 PAIR 3 = OPEN
 PAIR 3 = ETHERNET T568B
 PAIR 4 = ADT
 PAIR 4 = ETHERNET T568B
 PAIR 4 = ETHERNET T568B

ELECTRICAL SYMBOLS


SYMBOLS		ABBREVIATIONS	
	JUNCTION BOX (J-BOX)	EL	ELEVATION ABOVE FINISHED FLOOR
	ELECTRICAL STUB-UP	Α	AMPERES
0	EQUIPMENT CONNECTION	V	VOLTS
	DUPLEX CONVENIENCE OUTLET (DCO)	W	WATTS
\bigcirc	SINGLE CONVENIENCE OUTLET (SCO)	PH	PHASE
	SINGLE POWER OUTLET (SP)	AFF	ABOVE FINISHED FLOOR
•	FLOOR RECEPTACLE	DFA	DOWN FROM ABOVE
\Diamond	LIGHT INDICATION	BTC	BRANCH TO CONN— ECTION POINT AND CONNECT EQUIPMENT
	BREAKER PANELBOARD	SU	STUB UP ABOVE
\$	SWITCH AS NOTED		FINISHED FLOOR
M	MOTOR OUTLET	HP	HORSE POWER
B	BLOWER COIL MOTOR	KW	KILLOWATTS
	HEAT ELEMENT	DC	DIRECT CONNECTION
	FLOOR BOX (FL. BOX)	KES	KITCHEN EQUIPMENT SUPPLIER


ELECTRICAL NOTES


NOTES

- ALL ELECTRICAL OUTLETS SHOWN ON THIS PLAN ARE FOR FIXTURES SPECIFIED AS FURNISHED BY THE KITCHEN EQUIPMENT SUPPLIER. FOR FURTHER BLDG ELECTRICAL REQUIREMENTS (TELEPHONES, CLOCKS, SIGNS, EXHAUST HOOD SWITCHING, ETC.) SEE OTHER PLANS
- ALL DIMENSIONS GIVEN ARE IN INCHES TO 2'-O" AND AR FROM CENTERLINES AND/OR FINISHED WALLS. ELEVATIONS GIVEN ARE FROM FINISHED FLOOR TO CENTERLINE OF OUTLET. ALL ROUGH-INS SHOWN ARE TO BE RUN INSIDE WALLS (EXCEPT STUB-UPS). LOCATION INDICATES POINT OF EXIT FROM WALLS, CEILINGS OR FLOORS. ALL CONVENIENCE OUTLETS ARE TO BE SET HORIZONTALLY. ALL 120 VOLT OUTLETS NOT DESIGNATED WITH SPECIFIC LOADS TO BE RATED AT 20.0 AMPS.
- ELECTRICIAN TO CONNECT ALL ELECTRICAL EQUIPMENT AND FIXTURES AND DO ANY INTERNAL WIRING REQUIRED IN THE FIXTURES AS REQUIRED BY THE SPECIFICATIONS. ALL ELECTRICAL OUTLET COVER PLATES ARE TO BE STAINLESS STEEL AND ARE TO BE FURNISHED BY THE ELECTRICIAN, AS WELL AS THE RECEPTACLE, UNLESS OTHERWISE SPECIFIED IN THE ITEM SPECIFICATIONS.

 KITCHEN EQUIPMENT SUPPLIER TO FURNISH A GALVANIZED JUNCTION BOX IN THE FIXTURE CUTOUT TO RECEIVE THE RECEPTACLE, UNLESS OTHERWISE NOTED. ALL DISCONNECT SWITCHES REQUIRED ARE TO BE FURNISHED AND INSTALLED BY THE ELECTRICIAN AT
- D ALL WORK TO BE PERFORMED IN FULL ACCORDANCE WITH ALL APPLICABLE CODES RELATING TO HOOK-UP, INSTALLATION AND WIRING OF EQUIPMENT. OMISSIONS OR ERRORS ON THE SCHEDULE DO NOT RELIEVE THE ELECTRICIAN FROM COMPLETE FINAL CONNECTION
- E | ELECTRICAL REQUIREMENTS FOR THIS AREA SHALL BE SPECIFIED AND LOCATED BY OTHERS.
- F CONTROL CIRCUIT FROM ELECTRICIAN FURNISHED AND INSTALL SHUNT TRIP BREAKER(S) TO FIRE CONTROL SYSTEM CONTROL MICRO—. SWITCH. SHUNT TRIP BREAKER(S) TO BE UNDER EXHAUST HOOD. IN CASE OF FIRE, ALL POWER TO EQUIPMENT UNDER HOOD WILL BE SHUT OFF. ALL GAS EQUIPMENT LOCATED UNDER HOOD WILL ALSO BE SHUT OFF IN CASE OF FIRE. MUST BE WIRED THAT IN THE EVENT OF POWER FAILURE, FIRE CONTROL SYSTEM WILL NOT BE ACTIVATED AND WHEN POWER IS RESTORED, FIRE SYSTEM WILL NOT
- G SPIRAL WRAP NECESSARY LENGTH OF STRIP HEATER ON DRAIN LINE. USE "E-Z" HEAT (OR EQUAL) 120 1ph. WIRE HEATER TO FAN CIRCUIT OF BLOWER COIL SO THAT HEATER IS ALWAYS ON EXCEPT DURING DEFROST CYCLE. STRIP HEATER FURNISHED BY KITCHEN EQUIPMENT SUPPLIER TO ELECTRICAL CONTRACTOR FOR HOOK-UP.

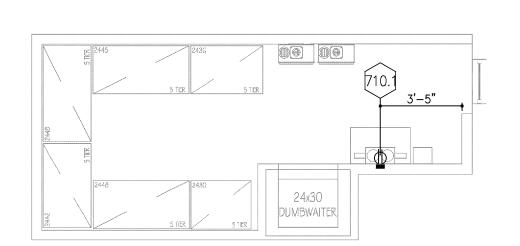

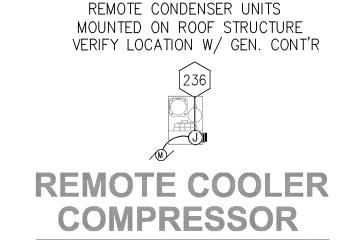

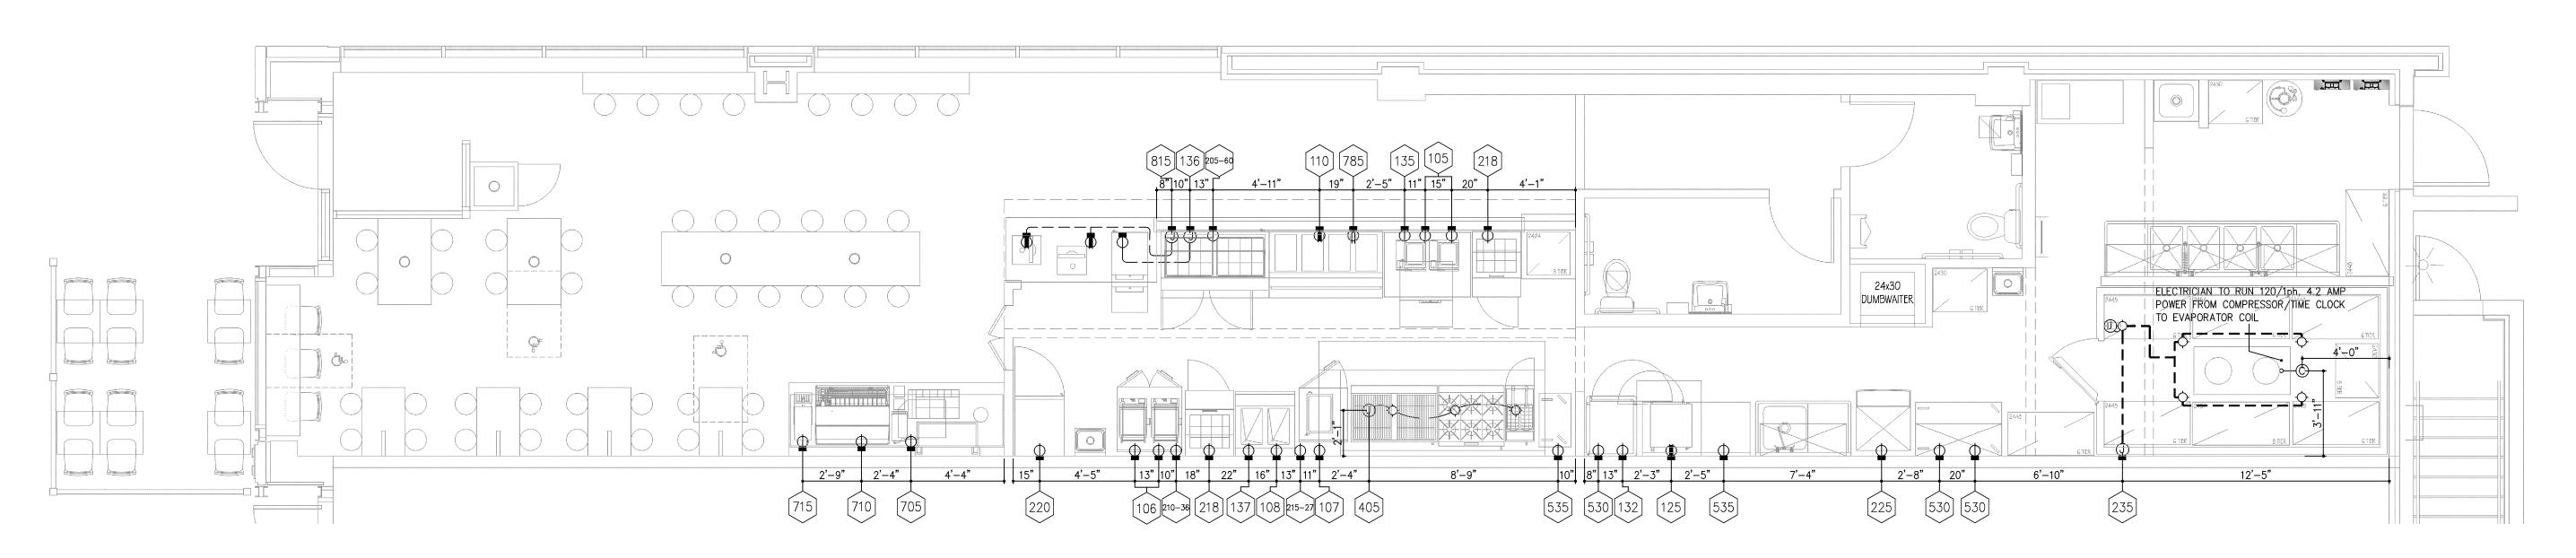


ELECTRICAL ROUGH-IN PLAN

SCALE 1/4" = 1'-0"


LINGLEDESIGNGROUP, INC
WEST MAIN STREET
LENA, IL 61048 158
PHONE: 815-369-9155
FAX: 815-369-4495
www.LINGLEDESIGN.COM



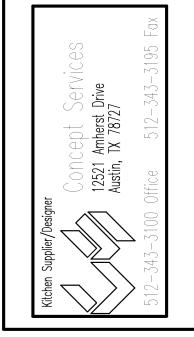

© ALL DRAWINGS AND WRITTEN MATERIAL CONTAINED HEREIN ARE THE PROPERTY OF THE ARCHITECT. THEY MAY NOT BE REVISED, COPIED, REUSED, OR DISCLOSED IN ANY MANNER WITHOUT WRITTEN AUTHORIZATION FROM THE ARCHITECT.



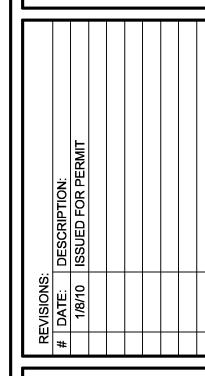

PROJECT NUMBER: 09-116
DRAWN BY: JI
CHECKED BY: MG

SHEET TITLE:

ELECTRICAL ROUGH-IN PLAN

SHEET NUMBER:

K3